
	1	2	3	4
G				
F				
E				
D			40'-0"	T/WALL = 650'
С			TYPICAL ALL	[640'] [6
В			CONNECTOR STRONG-TIE POST BASE.	RS: SIMPSON MODEL BC
A				
	1	2	3	4



5

1

6

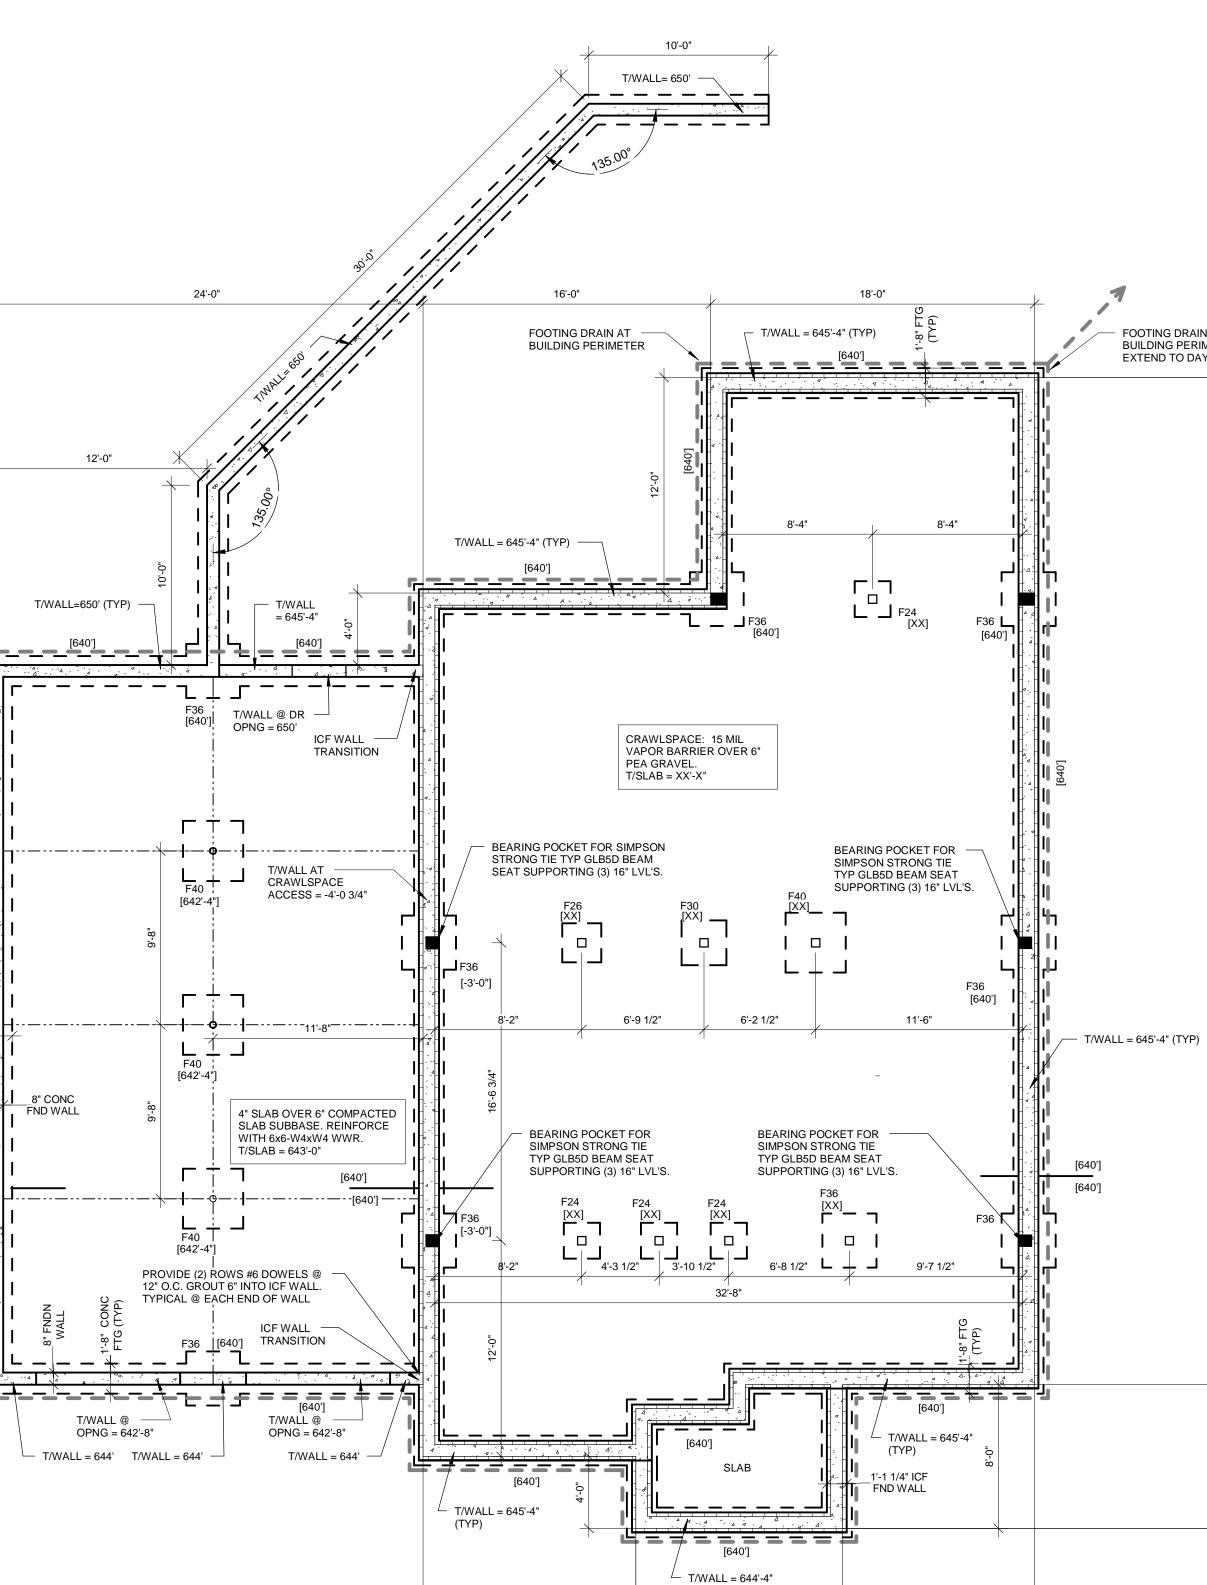

$ \begin{array}{c} 1 \end{array} \begin{array}{c} FOUNDATION PLAN \\ \hline 3/16" = 1'-0" \end{array} \end{array} $	FOOTING SCHEDULE				
3/16 = 1-0	ALLOWABL	ALLOWABLE SOIL BEARING PRESSURE (PSF)			
TUM ELEVATION (0") AT FIRST FLOOR EQUALS SITE ELEVATION (XXX').	CONCRETE	CONCRETE COMPRESSIVE STRENGTH (PSI)			
ELEVATIONS NOTED ARE WITH RESPECT TO DATUM ELEVATION. TOP OF PIER ELEVATION = (-8") (@ STEEL COLUMNS) TYPICAL UNLESS NOTED OTHERWISE AS (+X'-XX")	REINFORC	REINFORCEMENT YIELD STRENGTH (GRADE 60) (KSI)			
TOP OF FOOTING ELEVATION = AS SHOWN ON DRAWINGS AS [-X'-XX"] PX INDICATES PIER TYPE. SEE S301 FOR PIER PLAN DETAILS.		FOOTING SIZE LEGTH X WIDTH X DEPTH	REINFORCING		
SEE S300 FOR TYPICAL SLAB DETAILS. SEE S500 FOR COLUMN SCHEDULE.	FOOTING MARK		BOTTOM		
SEE S300 FOR PIER PLAN DETAILS. SEE S300 FOR BASE PLATE DETAILS.			SHORT	LONG	SHO
SEE S001 FOR CONCRETE AND MASONRY REINFORCING LAP SCHEDULES. PROVIDE (2) #4 x4'-0" LONG DIAGONAL AT SLAB REENTRANT CORNERS.	F24	2'-0" X 2'-0" X 10"	(3) #4	(3) #4	N/A
2. REFERENCE S500 FOR SHEARWALL SCHEDULE AND DETAILS.	F26	2'-2" X 2'-2" X 10"	(3) #4	(3) #4	N/A
	F30	2'-6" X 2'-6" X 10"	(3) #4	(3) #4	N/A
	F36	3'-0" X 3'-0" X 10"	(4) #4	(4) #4	N/A
	F40	3'-4" X 3'-4" X 10"	(4) #4	(4) #4	N/A

(TYP)

11'-6"

24'-0"

11'-10"

		7		8		9		10		
									Addition To Plans Bearing a Licensed Engineer's or Architect's Seal is a Violation of Section 7209 of the New	
										G
	18'-0"	I	, 1						Elwyn & Palmer	
			FOOTING DF BUILDING PI EXTEND TO	RAIN AT ERIMETER. DAYLIGHT					CONSULTING ENGINEERS, PLLC 213 East Seneca Street Ithaca, New York 14850 www.ElwynPalmer.com	
	/	8'-4"								
		24 [XX] F36 [[640]]	ין 1 1 1 1 1 1							
										E
	SIMPSON STR TYP GLB5D BE	ONG TIE	- 10 - 10 - 10 - 10 - 10 - 10	56'-0"						
	 	[640']	47 	9 7 7						D
	POCKET FOR		T/WALL = 645'-4" (T)	(P)						
	ING (3) 16" LVL'S. F36 [XX] Г Л									
		(TTYP)							$ \stackrel{\circ}{_{\circ}} O$	С
10-5* NDICATES LOCATION OF CONTRACTION JOINTS. SEE TYPICAL SLAB DEFAIL. NDICATES LEVATION INDICATES IEER TYPE. NDICATES LEVATION. NDICATES SPEEAD FOOTING & CANCETE PIER. NDICATES SPEEAD FOOTING & SPEEAD FOOTING & CANCETE PIER. NDICATES TOP OF SPEEAD FOOTING & SPEEAD FOOTING & CANCETE PIER. NDICATES TOP OF SPEEAD FOOTING & SPEEAD FOOTING	(TYI	ALL = 645'-4" P) ج تص		80-			_			
Image: Arrow of the concrete plane. Image: Arrow of the concord of the concrete plane. Image: Arro		10'-8"	<u>/</u>		[.]		 INDICATES LOCATION OF CON SEE TYPICAL SLAB DETAIL. INDICATES PIER TYPE. 			В
CONCRETE COMPRESSIVE STRENGTH (PSI) 3000 REINFORCEMENT YIELD STRENGTH (GRADE 60) (KSI) 60 FOOTING BOTTOM KEINFORCEMENT YIELD STRENGTH (GRADE 60) (KSI) 60 BOTTOM TOP MARK BOTTOM Y DEPTH REINFORCING BOTTOM TOP INDICATES FOUNDATION WALL STRIP FOOTING F24 2-0° X 2-0° X 10° (3) #4 (3) #4 (4) #4 (4) #4 F30 2-6° X 2-6° X 10° (4) #4 (4) #4 F40 3-4° X 3-4° X 10° (4) #4 (4) #4 (3) #4 (4) #4		ALLOWABLE SOIL BEA		2000		(XXX'-X")	 INDICATES SPREAD FOOTING INDICATES SPREAD FOOTING INDICATES TOP OF SPREAD F 	& CONCRETE PIER. TYPE. OOTING ELELVATION.	O L N DATE: 2021.10.20 PROJECT: 2019002	
F24 2'-0" X 2'-0" X 10" (3) #4 (3) #4 N/A N/A F26 2'-2" X 2'-2" X 10" (3) #4 (3) #4 N/A N/A F30 2'-6" X 2'-6" X 10" (3) #4 (3) #4 N/A N/A F36 3'-0" X 3'-0" X 10" (4) #4 N/A N/A F40 3'-4" X 3'-4" X 10" (4) #4 N/A N/A INDICATES TYP CONC FND WALL INDICATES TYP CONC FND WALL INDICATES TYP CONC FND WALL INDICATES TOP/FTG ELEVATION FROM DATUM. S1000		CONCRETE COMPRES REINFORCEMENT YIEL FOOTING FOOTIN LEGTH X	SIVE STRENGTH (PSI) D STRENGTH (GRADE 60) (K G SIZE WIDTH PTH BOTTOM	3000 SI) 60 ORCING TOP	Ť			DE)	DRAWN BY: Author FOUNDATION	
		F26 2'-2" X 2'- F30 2'-6" X 2'- F36 3'-0" X 3'-	0" X 10" (3) #4 (3) #4 2" X 10" (3) #4 (3) #4 6" X 10" (3) #4 (3) #4 0" X 10" (4) #4 (4) #4	N/AN/AN/AN/AN/AN/AN/AN/A			FOUNDATION WALL INDICATES TYP CONC FND W	ALL		A
				8		9		10	5100	